

KEVIN COWAN  
ARCHITECTS


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SHAWNEE MISSION SCHOOL DISTRICT  
2017 FLOORING IMPROVEMENTS  
SHAWNEE MISSION NORTHWEST HIGH SCHOOL,  
SHAWNEE MISSION SOUTH HIGH SCHOOL  
FOR BID/CONSTRUCTION  
KCA PROJECT NO. 1645/SMSD BID NO. 17-003  
JANUARY 31ST, 2017

ABBREVIATIONS		PLAN SYMBOLS		SCHOOLS INDEX	SHEET INDEX	GENERAL NOTES	GENERAL NOTES CONT.		
AB A/C ACQ AD ADD ADJ AFF AHU AL ALT ALUM ANOD AP APPROX APPRV ARCH ASPH ASSY AUTO AUX B TO B BAL BD BLDG BLK BLKG BIM BM B.M. B.O. BOS BOT BASE PL BR BRG BRK BRZ BSMT BTU BUR C CB C TO C CAB CFLG C & G CHKR CK CI CJ CLG CLOS CLR CM CMP CMU C.O. CO COL COMM CONC COND CONN CONSTR CONT CTRL CONTR CORP CORR CRS CS CTS CI CM CY DBL DEG DEPT DET DIA DIAG DIM DISC DISP DIV DN DN OPNG	AT ANCHOR BOLT AIR CONDITIONER ACOUSTICAL AREA DRAIN ADDENDUM ADJACENT ABOVE FINISH FLOOR AIR HANDLING UNIT ACTIVE LEAF ALTERNATIVE (ALTERNATE) ALUMINUM ANODIZED ANCHOR PLATE APPROXIMATE APPROVAL (APPROVE) ARCHITECTURE ASPHALT ASSEMBLY AUTOMATIC AUXILIARY BACK TO BACK BALANCE BOARD BUILDING BLOCK BLOCKING BILL OF MATERIAL BEAM BENCH MARK BOTTOM OF BOTTOM OF STEEL BOTTOM BASE PLATE BEDROOM BEARING BRICK BRONZE BASEMENT BRITISH THERMAL UNITS BUILT-UP ROOFING CHANNEL CHALKBOARD CENTER TO CENTER CABINET COUNTER FLASHING CURB AND GUTTER CHECKER CHECK CAST IRON CONTROL JOINT CENTER LINE CEILING CLOSET CLEAR (CLEARANCE) CENTIMETER CORRUGATED METAL PIPE CONCRETE MASONRY UNIT CLEAN OUT COMPANY COLUMN COMMUNICATION CONCRETE CONDITION CONNECT (CONNECTION) CONSTRUCTION CONTINUE (CONTINUOUS) CONTROL CONVEYOR CORPORATION CORRUGATED CORRIDOR COURSES/COLD ROLLED STEEL CAST STEEL COUNTERSINK CUBIC FEET CUBIC INCH CUBIC METER CUBIC YARD DOUBLE DEGREE DEPARTMENT DETAIL DIAMETER DIAGONAL DIMENSION DISCONNECT DISPENSER DIVISION DOWN DOWN OPENING	DR DRAIN DOWN SPOUT DISHWASHER DRAWING DOWEL DRAWN EAST EXP BOLT EXPLOSION ELEV EMER ENCL ENGR ENTR EQ EQUIPMENT ETC EXC EXHAUST EXP EXP ANCH EXPANSION JOINT EXIST EXT F TO F FAB FACE FURNISHED BY OTHERS FLOOR DRAIN FOUNDATION FIRE EXTINGUISHER FIRE EXTINGUISHER CABINET FINISH FLOOR FINISH FIGURE FLOOR FINISH FIXTURE FLG FLSHG FT FTG FURNACE FORWARD FWD GA GALLON GALV G.B. GRAB BARS GENERAL CONTRACTOR GENERAL GLASS GRD GRADE GYPSUM GYPSUM BOARD H8 HOSE BIBB HOLLOW CORE HD HEAD HDBR HEADWARE HDWR HANGER HGR HM HMD HMF HORIZ HOUR HS HEIGHT HTR HVAC HW HWH ID INCH INC INFO INSUL JAN JUNCTION BOX JOIST JOINT KITCHEN KNOCK OUT	LAB LABORATORY LAV LAVATORY LAM LAMINATED LB POUND L (LG) LONG LEG LHRS LEFT HAND REVERSE BEVEL LIN LINEAL LN LONG LEG HORIZONTAL LLV LONG LEG VERTICAL LTG LIGHTING LTL LITE LT WT LIGHT WEIGHT LVR LATCH MACH BOLT MAINT MAINTENANCE MAS MASONSRY MATL MATERIAL MAX MAXIMUM ME MEASUREMENT MECH MECHANICAL MED MEDIUM METL METAL MEZZANINE MFR MANUFACTURER MGMT MANAGEMENT MH MANHOLE MIN MINIMUM MIR MIRROR MISC MISCELLANEOUS MK MARK MM MILLIMETER MO MASONRY OPENING MULLION MULLION MS MACHINE SCREW MTD MOUNTED MTG MOUNTING N NORTH NIC NOT IN CONTRACT NO NUMBER NORM NORMAL NTS NOT TO SCALE OVR OVERALL OC ON CENTER OD OUTSIDE DIAMETER OPNG OPENING OPP OPPOSITE OVHD OVERHEAD OZ OUNCE P PIECE PCF POUNDS PER CUBIC FOOT P-LAM PLASTIC LAMINATE PERF PERFORATED PERM PERMANENT PHASE PKG PACKAGING (PACKAGE) PKWY PARKWAY PL PROPERTY LINE PLYWD PLYWOOD PRL PURCHASE ORDER PR PAIR PRECAST PREFAB PREFABRICATED PRELIM PRELIMINARY PREP PREPARATION PROJ PROJECT PSF POUNDS PER SQUARE FOOT PSI POUNDS PER SQUARE INCH PT POINT PTD PAINTED/PAPER TOWEL PTN PARTITION PVC POLYVINYL CHLORIDE PVT PAVEMENT PWR POWER QTY QUANTITY R RISER R.O.W. RIGHT OF WAY RAD RADIUS RCP REINFORCED CONC. PIPE RCMU REINFORCED CMU RCPT RECEPTACLE RD ROOF DRAIN RDL ROOF DRAIN LEADER REBAR REINFORCED BAR REC RECESSED	RECT RECTANGLE REFL REFERENCE REFL REFLECTED REFRIG REFRIGERATOR REINF REINFORCE REQ'D REQUIRED REV REVISE (REVISION) RFG ROOFING RH RIGHT HAND RM ROOM RO ROUGH OPENING RR RAILROAD RTN RETURN S SOUTH SANITARY SC SOLID CORE SCH SCHEDULE SD STORM DRAIN SECT SECTION SHT SHEET SHR SHIMLAR SK SKETCH SLV SLEEVE SMT SHEET METAL SP SPACE SPEC SPECIFICATION SQ SQUARE SS STAINLESS STEEL/ ST STREET SSK SERVICE SINK STA STATION STD STANDARD STIF STIFFENER STIR STIRRUP STL STEEL STOR STORAGE STRUCT STRUCTURAL SUPT SUPERINTENDANT SUPLY SUPERVISOR SUSP CLG SUSPENDED CEILING SW SWITCH SWBD SWITCHBOARD SWR SEVERE SYS SYSTEM TB TACK BOARD T & B TOP AND BOTTOM TECH TECHNICAL TEL TELEPHONE TEMP TEMPORARY T & G TONGUE AND GROOVE THD THREAD THK THICK THRU THROUGH T.O. TOP OF TOC TOP OF CURB TOS TOP OF STEEL TRT TREATED TYP TYPICAL UGND UNDERGROUND UH UNIT HEATER UNO UNLESS NOTED OTHERWISE UNPLUMB UNPLUMB V VOLT VAC VACUUM VAPOR BARRIER VCT VINYL COMPOSITION TILE VENT VENTILATION (VENTILATOR) VERT VERTICAL VWC VINYL WALL COVERING WF WIDE FLANGE W/O WITHOUT WDO WINDOW OPENING WO WALL OPENING WVC WATER CLOSET WD WOOD WDW WINDOW WHS WAREHOUSE WIP WROUGHT IRON WIP WROUGHT IRON PIPE WELD'G WELDING WTR PFG WATERPROOFING WP WORK POINT WT WEIGHT WTR WATER WWF WELDED WIRE FABRIC YD YARD YH YARD HYDRANT YR YEAR	XXXX DOOR NUMBERS (ON DOOR) H1-A201 STORAGE 105 A4-A501 SECTION INDICATOR 01 WINDOW NUMBER 02 WALL TYPE INDICATOR	1 SHAWNEE MISSION NORTHWEST HIGH SCHOOL 12701 W 67TH STREET SHAWNEE, KS 66216 2 SHAWNEE MISSION SOUTH HIGH SCHOOL 5800 WEST 107TH STREET OVERLAND PARK, KS 66207	ARCHITECTURAL DRAWINGS (17 SHEETS) 1 COVER SHEET SHAWNEE MISSION SOUTH HIGH SCHOOL (SMNW) 2 SMNW A001 OVERALL FIRST FLOOR PLAN 3 SMNW A002 OVERALL SECOND FLOOR PLAN 4 SMNW A003 EXISTING FLOORING IMAGE SHEET 5 SMNW A101 PARTIAL DEMOLITION FIRST FLOOR PLAN 6 SMNW A102 PARTIAL DEMOLITION FIRST FLOOR PLAN 7 SMNW A103 PARTIAL DEMOLITION SECOND FLOOR PLAN 8 SMNW A104 PARTIAL DEMOLITION SECOND FLOOR PLAN 9 SMNW A201 PARTIAL IMPROVEMENT FIRST FLOOR PLAN 10 SMNW A202 PARTIAL IMPROVEMENT FIRST FLOOR PLAN 11 SMNW A203 PARTIAL IMPROVEMENT SECOND FLOOR PLAN 12 SMNW A204 PARTIAL IMPROVEMENT SECOND FLOOR PLAN SHAWNEE MISSION SOUTH HIGH SCHOOL (SMS) 13 SMS A001 OVERALL FIRST FLOOR PLAN 14 SMS A101 PARTIAL ENLARGED DEMOLITION FLOOR PLAN 15 SMS A102 PARTIAL ENLARGED DEMOLITION FLOOR PLAN 16 SMS A201 PARTIAL ENLARGED IMPROVEMENT FLOOR PLAN 17 SMS A202 PARTIAL ENLARGED IMPROVEMENT FLOOR PLAN	1. ALL FLOORING CONTRACTORS SHALL VISIT EACH SITE PRIOR TO BIDDING TO EXAMINE AND VERIFY EXISTING CONDITIONS AND SCOPE OF WORK. NO COMPENSATION WILL BE AWARDED BASED ON LACK OF KNOWLEDGE OF ITEMS FOUND AFTER SUBMISSION OF BIDS. 2. EXISTING CONDITIONS ARE SHOWN BASED ON ORIGINAL BUILDING DOCUMENTS AND A VISUAL REVIEW OF EXISTING CONDITIONS. AN ATTEMPT HAS BEEN MADE TO DOCUMENT EXISTING CONDITIONS & ELEMENTS TO GREATEST EXTENT POSSIBLE, HOWEVER ALL ITEMS EXISTING MAY NOT BE SHOWN OR LABELED. THE CONTRACTOR SHALL VERIFY ALL EXISTING CONDITIONS PRIOR TO BID. NOTIFY ARCHITECT IN WRITING FOR CLARIFICATION OF INTENT PRIOR TO BID. 3. FLOORING CONTRACTOR SHALL PROTECT ALL SURFACES, SYSTEMS, FINISHES & MATERIALS SCHEDULED TO REMAIN FROM DAMAGE. 4. FLOORING CONTRACTOR SHALL PATCH AND REPAIR ALL EXISTING SURFACES, SYSTEMS, FINISHES & MATERIALS WHICH ARE TO REMAIN BUT ARE DAMAGED OR ALTERED BY THE WORK OF THIS CONTRACT. DAMAGED ITEMS SHALL BE REPLACED W/ NEW MATERIALS TO MATCH EXISTING, WHERE MATERIALS OR COLORS CANNOT BE MATCHED, FLOORING CONTRACTOR SHALL REPLACE THE ENTIRE SURFACE OR COMPONENT TO THE SATISFACTION OF THE OWNER. 5. SUBSTRATE PREPARATION SHALL BE PROVIDED AS PART OF BASE BID. PREPARATION SHALL INCLUDE, GRINDING, LEVELING AND PATCHING COMPOUNDS AND SEALANTS AS REQUIRED BY EXISTING SUBSTRATE CONDITIONS AND BY THE FLOORING MANUFACTURERS' WRITTEN INSTRUCTIONS. PREPARATION SHALL ALSO INCLUDE THE CLEANING AND TREATMENT OF SUBSTRATE CRACKS. WHERE NEW WORK UNDER THIS CONTRACT ABUTS EXISTING MATERIAL AND WORK TO REMAIN, PROVIDE EDGE OR TRANSITION STRIPS OR ALUMINUM FLAT THRESHOLDS (I.E. CARPET TO VCT, CARPET TO CONCRETE, CARPET TO RESINOUS, CARPET TO CARPET, VCT TO RESINOUS, RESINOUS TO CONCRETE, VCT TO WOOD, AND VCT TO CONCRETE) MAINTAIN EXISTING CONDITION WITH NO DAMAGE. WHERE NECESSARY SHAVE OFF/UNDERCUT EXISTING DOORS (WOOD OR METAL) TO CLEAR NEW FLOORING & PRIOR TO INSTALLING NEW TRANSITION STRIPS. FIELD VERIFY ALL CONDITIONS PRIOR TO COMMENCING WORK. MODIFY EXISTING BOTTOM MANUAL BOLTS WHERE THEY OCCUR AS REQ'D FOR COMPLETE & UNINHIBITED OPERATION. 6. SHALL REMAIN IN PLACE AND SHALL BE PROTECTED FROM DAMAGE, UNLESS NOTED OTHERWISE.	9. THE FLOORING CONTRACTOR SHALL VERIFY ALL LAYOUT DIMENSIONS AND NOTIFY THE ARCHITECT OF ANY DISCREPANCIES PRIOR TO PROCEEDING WITH CONSTRUCTION. 10. PLANS INDICATE THE SIZE, LOCATION, AND ARRANGEMENT OF CONSTRUCTION TO THE SCALE SHOWN. DIMENSIONS ARE PROVIDED FOR ALL LAYOUT AND CONSTRUCTION. DRAWINGS ARE NOT TO BE SCALED. 11. ALL DIMENSIONS ARE TO FINISH FACE (OF MATERIAL USED), UNLESS OTHERWISE INDICATED. 12. "TYPICAL" OR "TYP" MEANS TYPICAL FOR ALL SIMILAR CONDITIONS UNLESS OTHERWISE NOTED. 13. "PROVIDE" MEANS SUPPLY AND INSTALL. 14. NEW CONSTRUCTION ITEMS TO "MATCH EXISTING" REFERS TO LIKE ITEMS CURRENTLY INSTALLED IN EXISTING CONSTRUCTION/FINISHES. 15. THE FLOORING CONTRACTOR SHALL FURNISH ALL ITEMS SHOWN ON THE DRAWINGS UNLESS SPECIFICALLY NOTED OTHERWISE, EITHER ON THE DRAWINGS OR IN THE SPECIFICATIONS. 16. ALL WORK SHOWN "BY OTHERS" OR "NIC" OR "N.I.C." IS TO BE PERFORMED BY A CONTRACTOR UNDER CONTRACT TO THE OWNER OTHER THAN THIS PROJECT'S GENERAL CONTRACTOR OR HIS SUBCONTRACTORS AND IS NOT PART OF THE CONSTRUCTION AGREEMENT. THE FLOORING CONTRACTOR SHALL COORDINATE WITH ALL OTHER OWNER CONTRACTORS AS REQUIRED TO FACILITATE THIS CONTRACT WHILE ALLOWING FOR CONCESSIONS AS NEEDED TO FACILITATE OTHER CONTRACTORS' WORK. 17. NORTH ARROWS ON PLANS INDICATE <u>PLAN NORTH</u> , NOT TRUE NORTH.
		ARCHITECTURAL LEGEND		SCHOOL LOCATION MAP					

KCA PROJECT NO. 1645 - SMSD NO. 17-003  
SM NORTHWEST HIGH SCHOOL, SM SOUTH HIGH SCHOOL



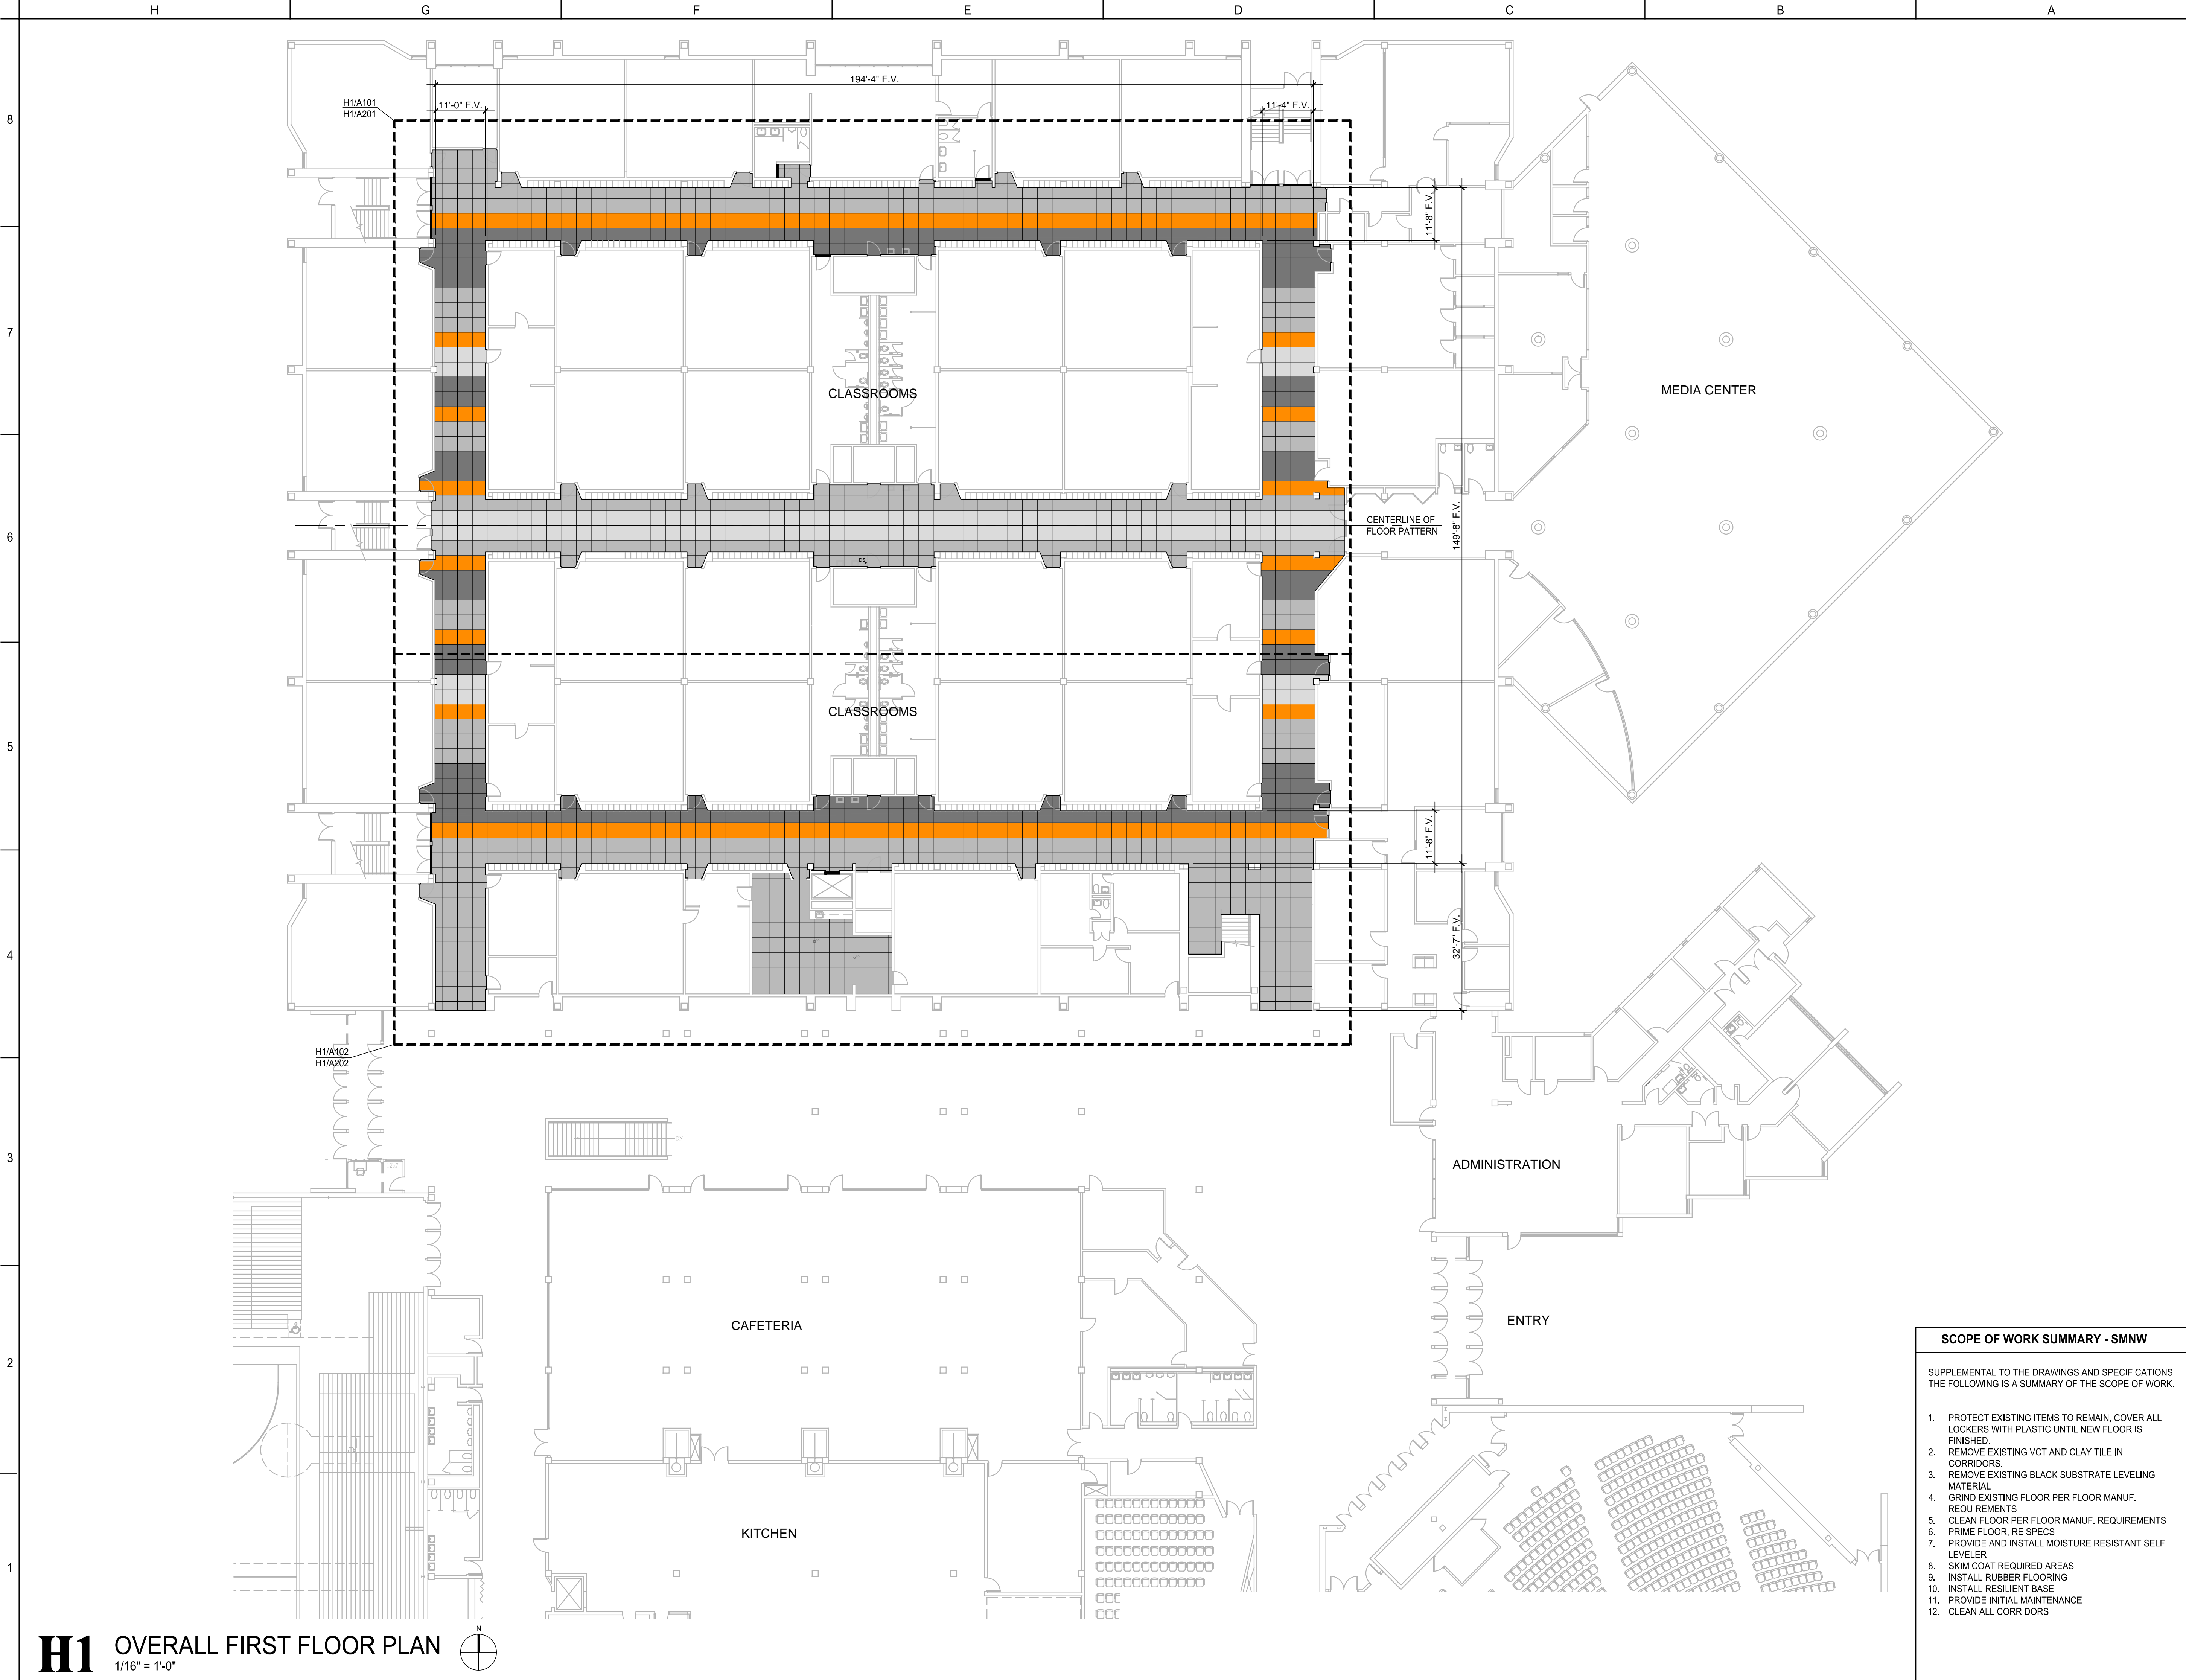

**H1** OVERALL FIRST FLOOR PLAN  
1/16" = 1'-0"

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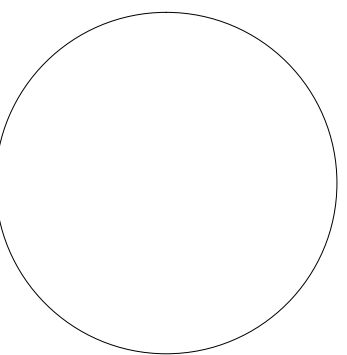
KCA PROJECT NO. 1645

**SMSD**

**2017  
FLOORING  
IMPROVE-  
MENTS**

**SHAWNEE  
MISSION  
NORTHWEST  
HIGH  
SCHOOL**

12701 W 67TH STREET  
SHAWNEE, KS 66216



ISSUE RECORD  
FOR BID/CONSTRUCTION 01/31/2017

Revision Record

**SCOPE OF WORK SUMMARY - SMNW**

SUPPLEMENTAL TO THE DRAWINGS AND SPECIFICATIONS  
THE FOLLOWING IS A SUMMARY OF THE SCOPE OF WORK.



1. PROTECT EXISTING ITEMS TO REMAIN, COVER ALL LOCKERS WITH PLASTIC UNTIL NEW FLOOR IS FINISHED.
2. REMOVE EXISTING VCT AND CLAY TILE IN CORRIDORS.
3. REMOVE EXISTING BLACK SUBSTRATE LEVELING MATERIAL.
4. GRIND EXISTING FLOOR PER FLOOR MANUF. REQUIREMENTS.
5. CLEAN FLOOR PER FLOOR MANUF. REQUIREMENTS.
6. PRIME FLOOR, RE SPECS.
7. PROVIDE AND INSTALL MOISTURE RESISTANT SELF LEVELER.
8. SKIM COAT REQUIRED AREAS.
9. INSTALL RUBBER FLOORING.
10. INSTALL RESILIENT BASE.
11. PROVIDE INITIAL MAINTENANCE.
12. CLEAN ALL CORRIDORS.

**OVERALL  
FIRST FLOOR  
PLAN**

**SMNW**

**A001**



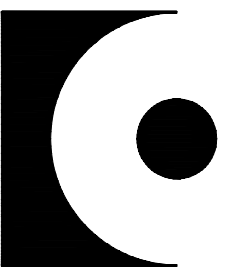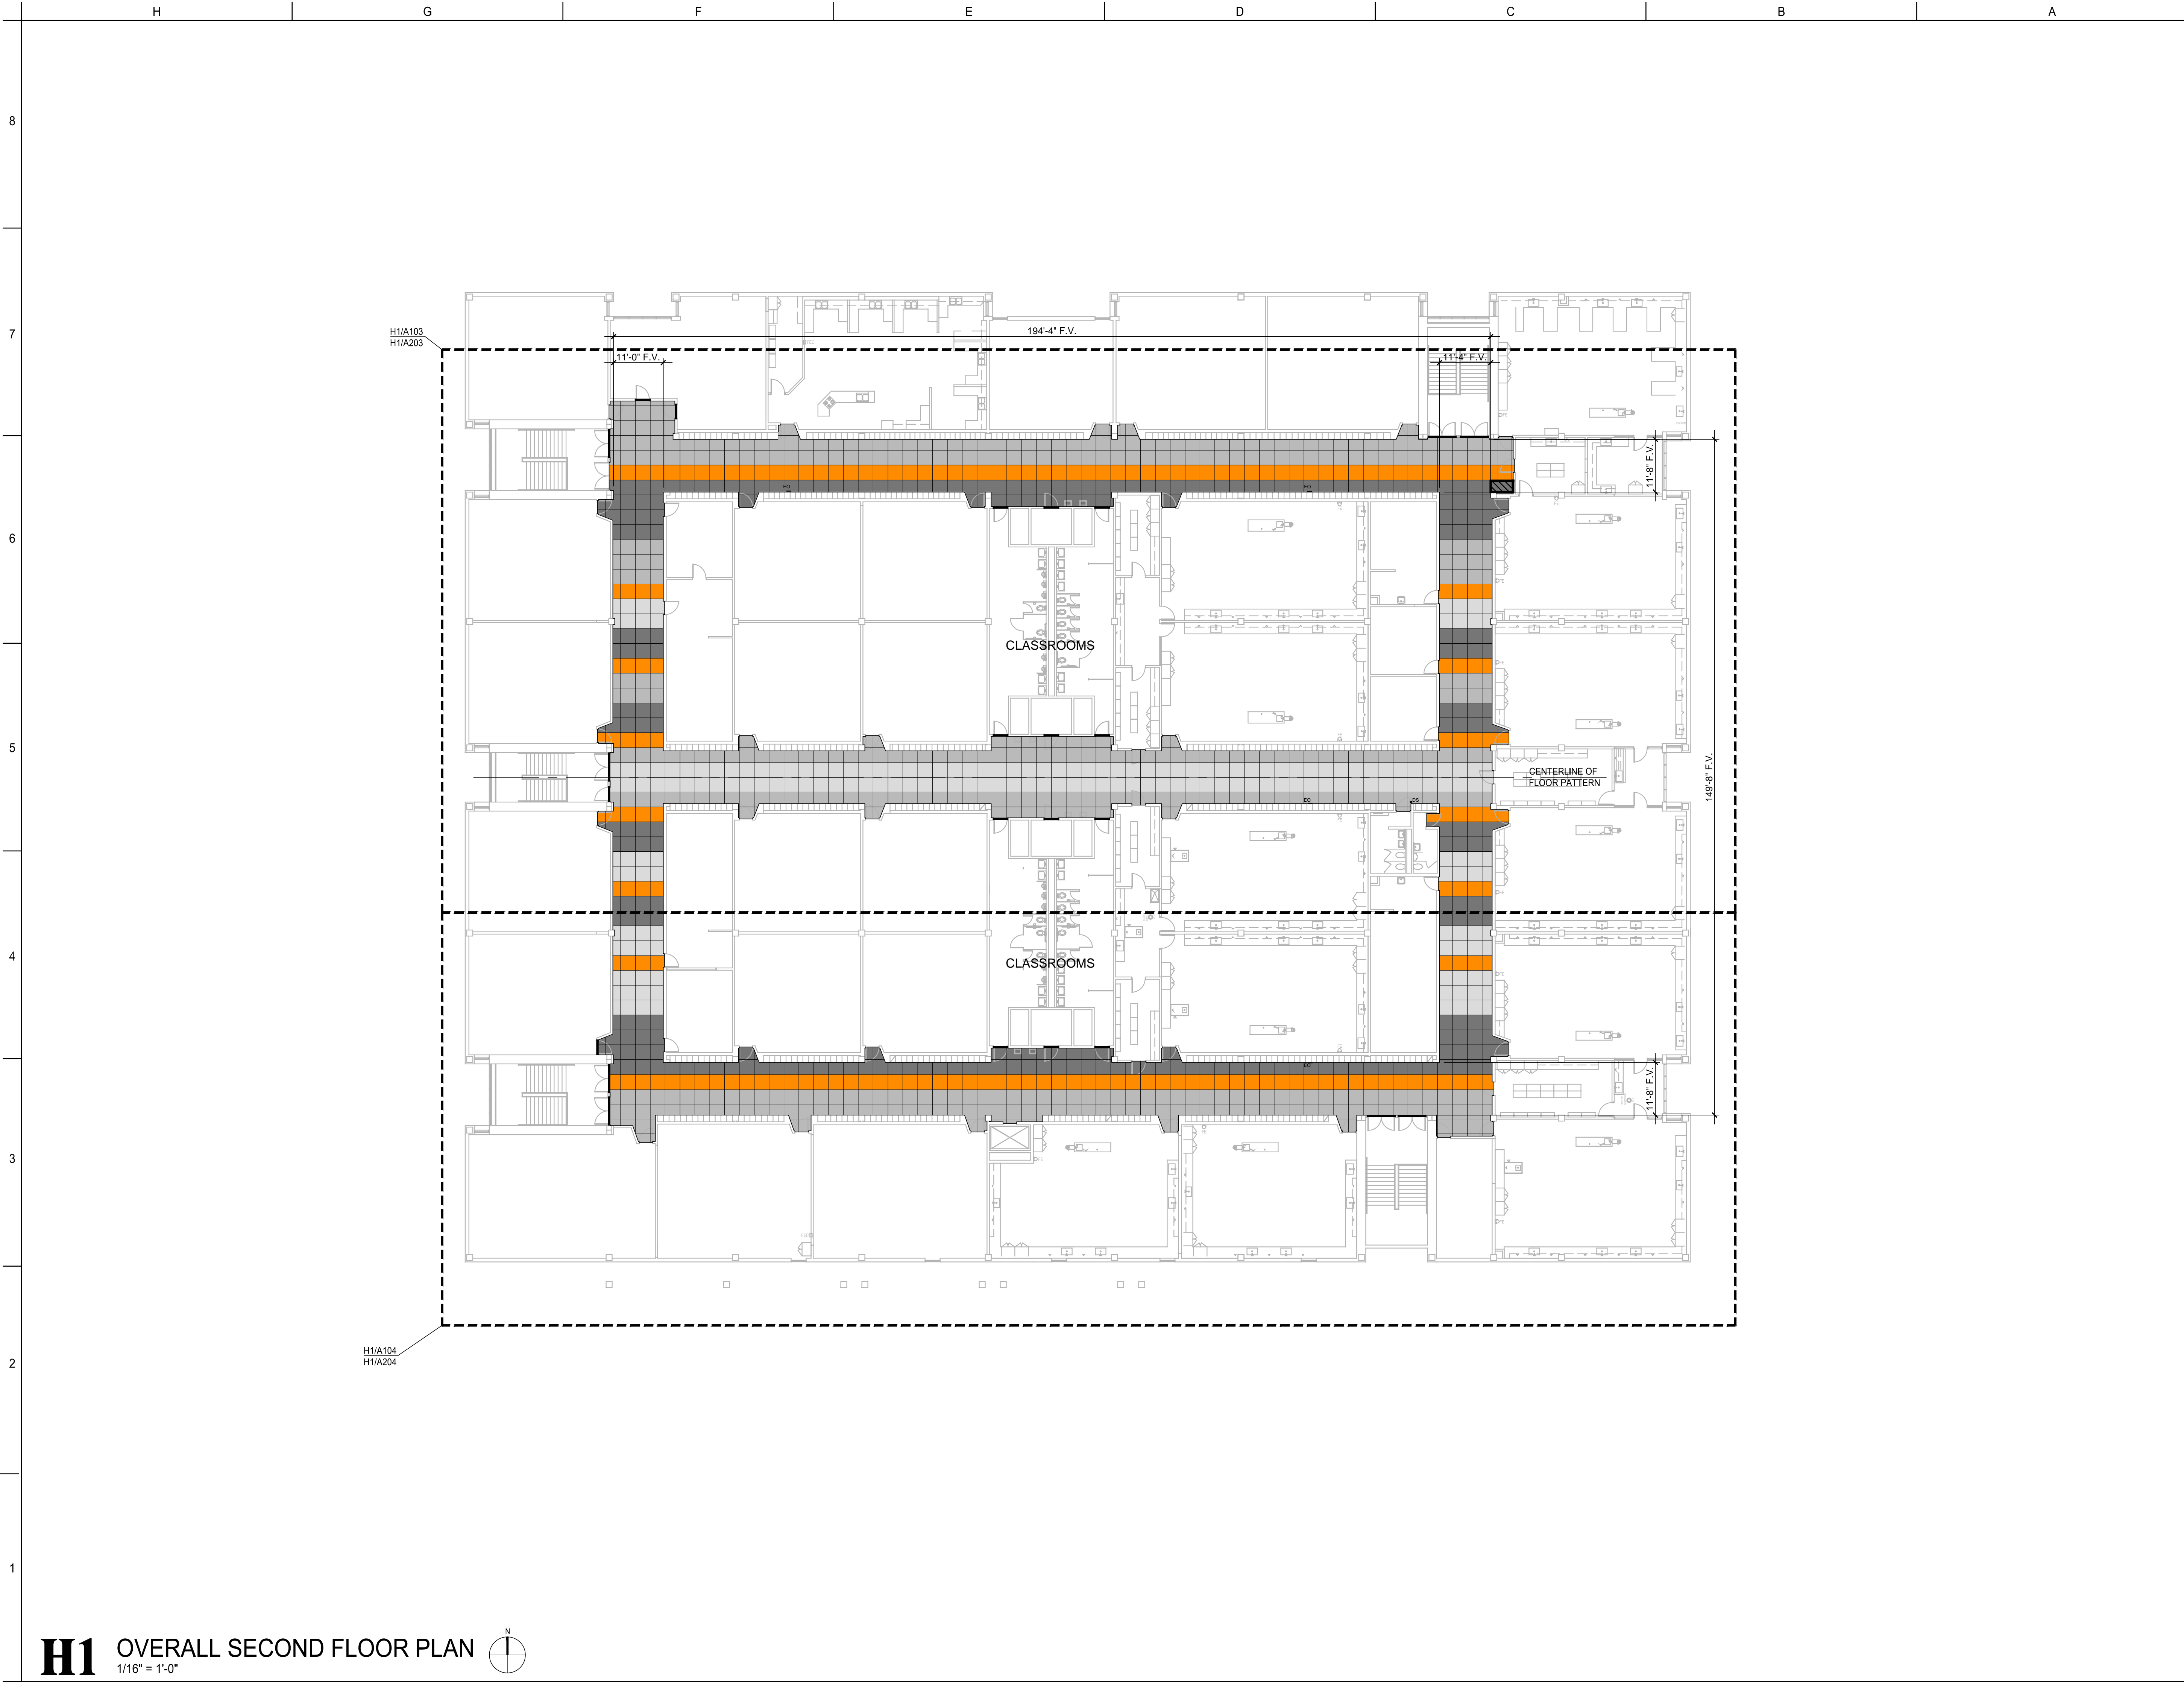

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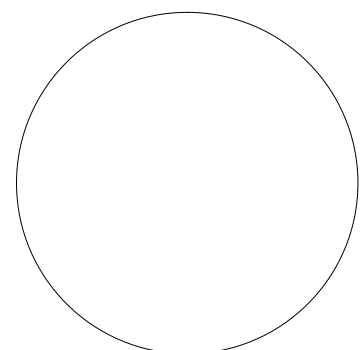
KCA PROJECT NO. 1645



## 2017 FLOORING IMPROVE- MENTS

## SHAWNEE MISSION NORTHWEST HIGH SCHOOL

12701 W 67TH STREET  
SHAWNEE, KS 66216



ISSUE RECORD

FOR BID/CONSTRUCTION 01/31/2017

Revision Record

## OVERALL SECOND FLOOR PLAN

# SMNW

# A002

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**H1 PARTIAL DEMOLITION FIRST FLOOR PLAN**  
1/8" = 1'-0"

The plan shows a grid of classrooms (112-137), restrooms (Boys, Girls, Mens, Womens), a Faculty Lounge, Janitor rooms, and Corridors. A large section of the building is marked with a cross-hatch pattern, indicating areas to be demolished. The plan includes room numbers, names, and 'NO WORK' labels. A north arrow and scale (1/8" = 1'-0") are provided at the bottom left.

[illegible]

# PARTIAL DEMOLITION FIRST FLOOR PLAN

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**SMNW**


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**A101**

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H		G		F		E		D		C		B		A	
										GENERAL NOTES		DEMOLITION PLAN NOTES		LEGEND-DEMOLITION	
8										1. REMOVE & SALVAGE EXISTING FLOOR MOUNTED DOOR STOPS IN ALL ROOM AFFECTED BY NEW FLOORING. REINSTALL UPON COMPLETION OF NEW FLOORING WORK. (NOTE: NOT ALL DS ARE SHOWN)		1 REMOVE & DISPOSE OF EXISTING VCT, BLACK SUBSTRATE LEVELING MATERIAL, RESILIENT BASE & TRANSITION STRIPS.		EXISTING CONST. TO REMAIN	
										2. USE CAUTION WHILE REMOVING RESILIENT BASE FROM WALLS W/PAINTED GRAPHICS TO REMAIN. CONTRACTOR RESPONSIBLE TO REPAIR OR PAY FOR REPAIRS BY OWNER IF DAMAGED.		2 REPAIR SURFACE CRACKS, GROOVES, DEPRESSIONS, CONTROL JOINTS IN ACCORDANCE W/RUBBER FLOOR MANUFACTURERS RECOMMENDATIONS.		NOTE APPLIES TO SPECIFIC ITEM	
7										3. CONTRACTOR SHALL MOVE & REATTACH EXISTING FLOOR DISPLAY CASES TO LIMITS OF WORK.		3 OWNER SHALL REMOVE & STORE CONTENTS OUT OF DISPLAY CABINETS.		NOTE APPLIES TO ENTIRE ROOM U.N.O.	
										4. FLOOR SHALL BE GRINDED, PREPPED & LEVEL PER RUBBER FLOOR MANUFACTURERS RECOMMENDATIONS. IF NO TRANSITION STRIP IS IDENTIFIED THE NEW FLOORING SHALL BE PREPPED & LEVEL TO BE FLUSH W/EXISTING FLOOR FINISH REMAINING. THUS NOT REQUIRING ANY RESILIENT TRANSITION UNLESS OTHERWISE NOTED TO OCCUR.		4 REMOVE, & DISPOSE OF EXISTING RESILIENT BASE ON BASE CABINETS, PREP & REMOVE ALL MASTICS.		DEMO - VCT & RESILIENT BASE	
												5 REMOVE, SALVAGE & REINSTALL EXISTING FLOOR CLEANOUTS UPON COMPLETION OF NEW FLOORING.		DEMO RESILIENT TRANSITION STRIP	
												6 FULLY COVER ALL LOCKERS W/PLASTIC PRIOR TO STARTING DEMOLITION. DO NOT REMOVE UNTIL FINAL FLOORING IS INSTALLED.		EXISTING TRANSITION STRIP AS OCCURS	
												7 REMOVE & DISPOSE OF EXISTING CLAY TILE, BLACK SUBSTRATE LEVELING MATERIAL, RESILIENT BASE & TRANSITION STRIPS. CUT TILE @ THRESHOLDS OF DOORS.		EO ELECTRICAL OUTLET	
														DS DOOR STOP	





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MENTS**

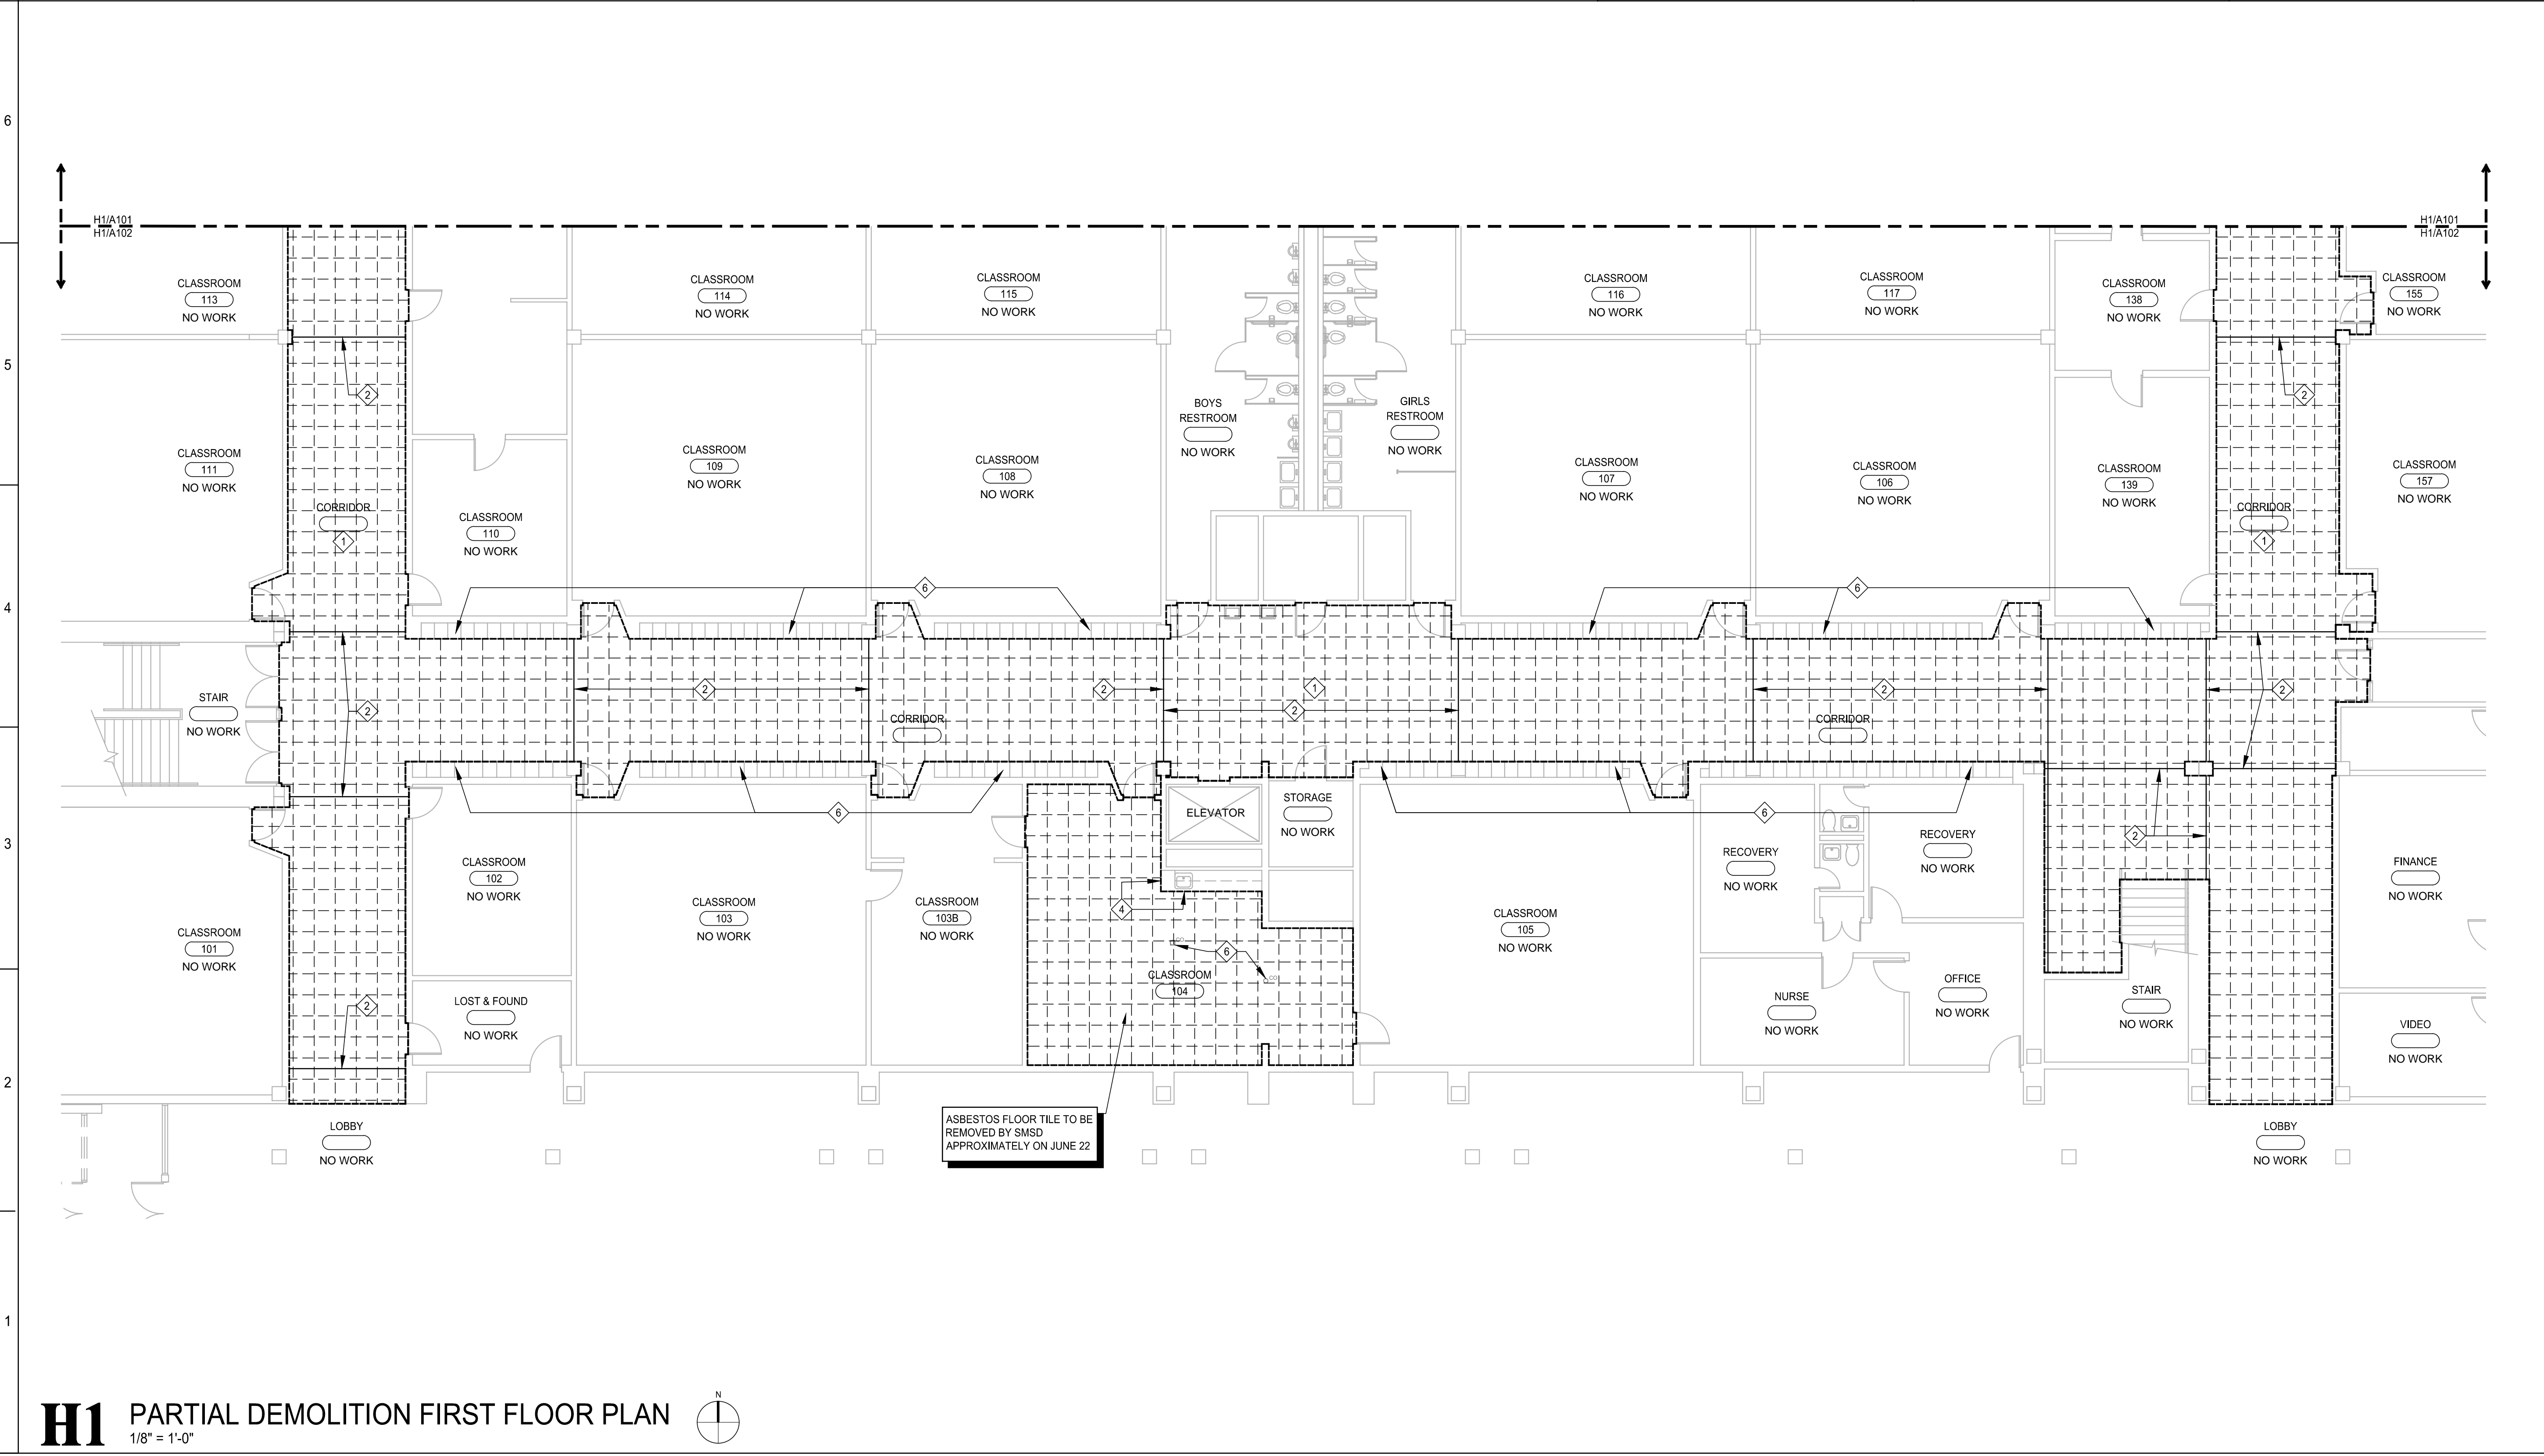**SHAWNEE  
MISSION  
NORTHWEST  
HIGH  
SCHOOL**  
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SHAWNEE, KS 66216

ISSUE RECORD	
FOR BID/CONSTRUCTION	01/31/2017

Revision Record	

**PARTIAL  
DEMOLITION  
FIRST  
FLOOR PLAN**

**SMNW  
A102**












**H1 PARTIAL IMPROVEMENT FIRST FLOOR PLAN**  
1/8" = 1'-0"

The plan shows a first floor layout with various rooms and corridors. Key areas include:

- Classrooms:** 113, 114, 115, 116, 117, 118, 119, 120, 121, 122, 123, 124, 125, 126, 127, 128, 129, 130, 131, 132, 133, 134, 135, 143, 144, 145, 146, 147, 148, 149, 150, 151, 152, 153, 154, 155.
- Corridors:** 1, 2, 3, 99, 100.
- Restrooms:** BOYS RESTROOM, GIRLS RESTROOM, MENS RESTROOM, WOMENS RESTROOM.
- Other Rooms:** JANITOR, DS, STAIR, FACULTY LOUNGE, LIBRARY.

Work status is indicated for each room (e.g., "NO WORK"). The plan also shows a north arrow, a scale bar (1/8" = 1'-0"), and section cut markers (H1/A201, H1/A202).



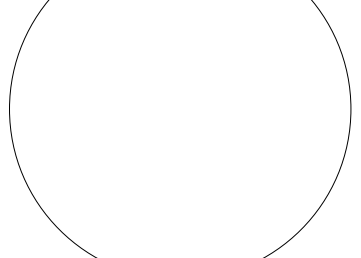

**ISSUE RECORD**

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**FOR BID/CONSTRUCTION**

**01/31/2017**

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Revision Record

# PARTIAL IMPROVEMENT FIRST FLOOR PLAN


# SMNW

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# A201



H		G		F		E		D		C		B		A	
						COLOR LEGEND		GENERAL NOTES		IMPROVEMENT PLAN NOTES CONT.		IMPROVEMENT PLAN NOTES		LEGEND-NEW WORK	
8						BASIS OF DESIGN NORAMENT, SATURA; OR PRE BID APPROVED EQUAL		1. REMOVE & SALVAGE EXISTING FLOOR MOUNTED DOOR STOPS IN ALL ROOM AFFECTED BY NEW FLOORING. REINSTALL UPON COMPLETION OF NEW FLOORING WORK. (NOTE: NOT ALL DS ARE SHOWN)		8 EXISTING BRICK, DO NOT INSTALL RESILIENT BASE UNLESS NOTED OTHERWISE.		1 NEW RUBBER FLOOR TILE & RESILIENT BASE (FIELD VERIFY HEIGHT TO MATCH EXISTING BASE) FLOORING CONTRACTOR SHALL PREP SUBSTRATE & INCLUDE FLOOR GRINDING, FLOOR LEVELING, PATCHING COMPOUNDS, CRACK REPAIR & CLEANING OF EXISTING SLAB ACCEPTABLE TO FLOOR MANUFACTURER.		EXISTING CONST. TO REMAIN	
						COLOR-1: CYGNUS 5105		2. USE CAUTION WHILE REMOVING RESILIENT BASE FROM WALLS W/PAINTED GRAPHICS TO REMAIN. CONTRACTOR RESPONSIBLE TO REPAIR OR PAY FOR REPAIRS BY OWNER IF DAMAGED.		9 OWNER SHALL REMOVE CONTENTS OF DISPLAY CASE & REINSTALL UPON COMPLETION OF FLOORING INSTALL.		2 FIELD VERIFY AREAS OF ADDITIONAL FLOOR PREP REQUIRED, PROVIDE CEMENTITIOUS LEVELING UNDERLAYMENT AS RECOMMENDED BY FLOOR MANUFACTURER.		# NOTE APPLIES TO SPECIFIC ITEM	
						COLOR-2: ARA 5110		3. CONTRACTOR SHALL MOVE & REATTACH EXISTING FLOOR DISPLAY CASES TO LIMITS OF WORK.		10 NEW RUBBER FLOORING & RESILIENT BASE, (MATCH EXISTING HEIGHT), PREP SUBSTRATE AS RECOMMENDED BY FLOOR MANUFACTURER.		3 CRACK REPAIR RE:H7/A201 AS RECOMMENDED BY FLOORING MANUFACTURER.		# NOTE APPLIES TO ENTIRE ROOM U.N.O.	
						COLOR-3: JUPITER 5120		4. FLOOR SHALL BE GRINDED, PREPPED & LEVEL PER RUBBER FLOORING MANUFACTURERS RECOMMENDATIONS SO IF NO TRANSITION STRIP IS IDENTIFIED THE NEW FLOORING SHALL BE PREPPED & LEVEL TO BE FLUSH W/EXISTING FLOOR FINISH REMAINING, THUS NOT REQUIRING ANY RESILIENT TRANSITION UNLESS OTHERWISE NOTED TO OCCUR.		11 OWNER SHALL REMOVE ALL FURNITURE, REFRIGERATOR, ETC. & REINSTALL UPON COMPLETION OF NEW WORK.		4 NEW TRANSITION @ RUBBER FLOORING & EXISTING CARPET.		H1/A201 ELEVATION MARK (IDENTIFIER/ SHEET NUMBER)	
						COLOR-4 : CASTOR 5111				12 REINSTALL CLEANOUT COVERS UPON COMPLETION OF NEW FLOORING.		5 NEW TRANSITION @ RUBBEER FLOORING & EXISTING CONCRETE SLAB.		H1/A201 ENLARGED AREA/ DETAIL BLOWUP (IDENTIFIER/ SHEET NUMBER)	
7										13 CONTRACTOR SHALL REINSTALL & ANCHOR STORED DISPLAY CASE IN ORIGINAL LOCATION.		6 NEW TRANSITION @ RUBBER FLOORING & EXISTING RESINOUS FLOORING.		EJ EXPANSION JOINT	
												7 CUT NEATLY & TRIM NEW BASE AROUND ELECTRICAL OUTLET MOUNTED IN BASE.		NEW RUBBER TILE FLOORING & RESILIENT BASE	
														NEW TRANSITION STRIP	
														EO ELECTRICAL OUTLET	
														DS DOOR STOP	
														NEW - CARPET & RESILIENT BASE	



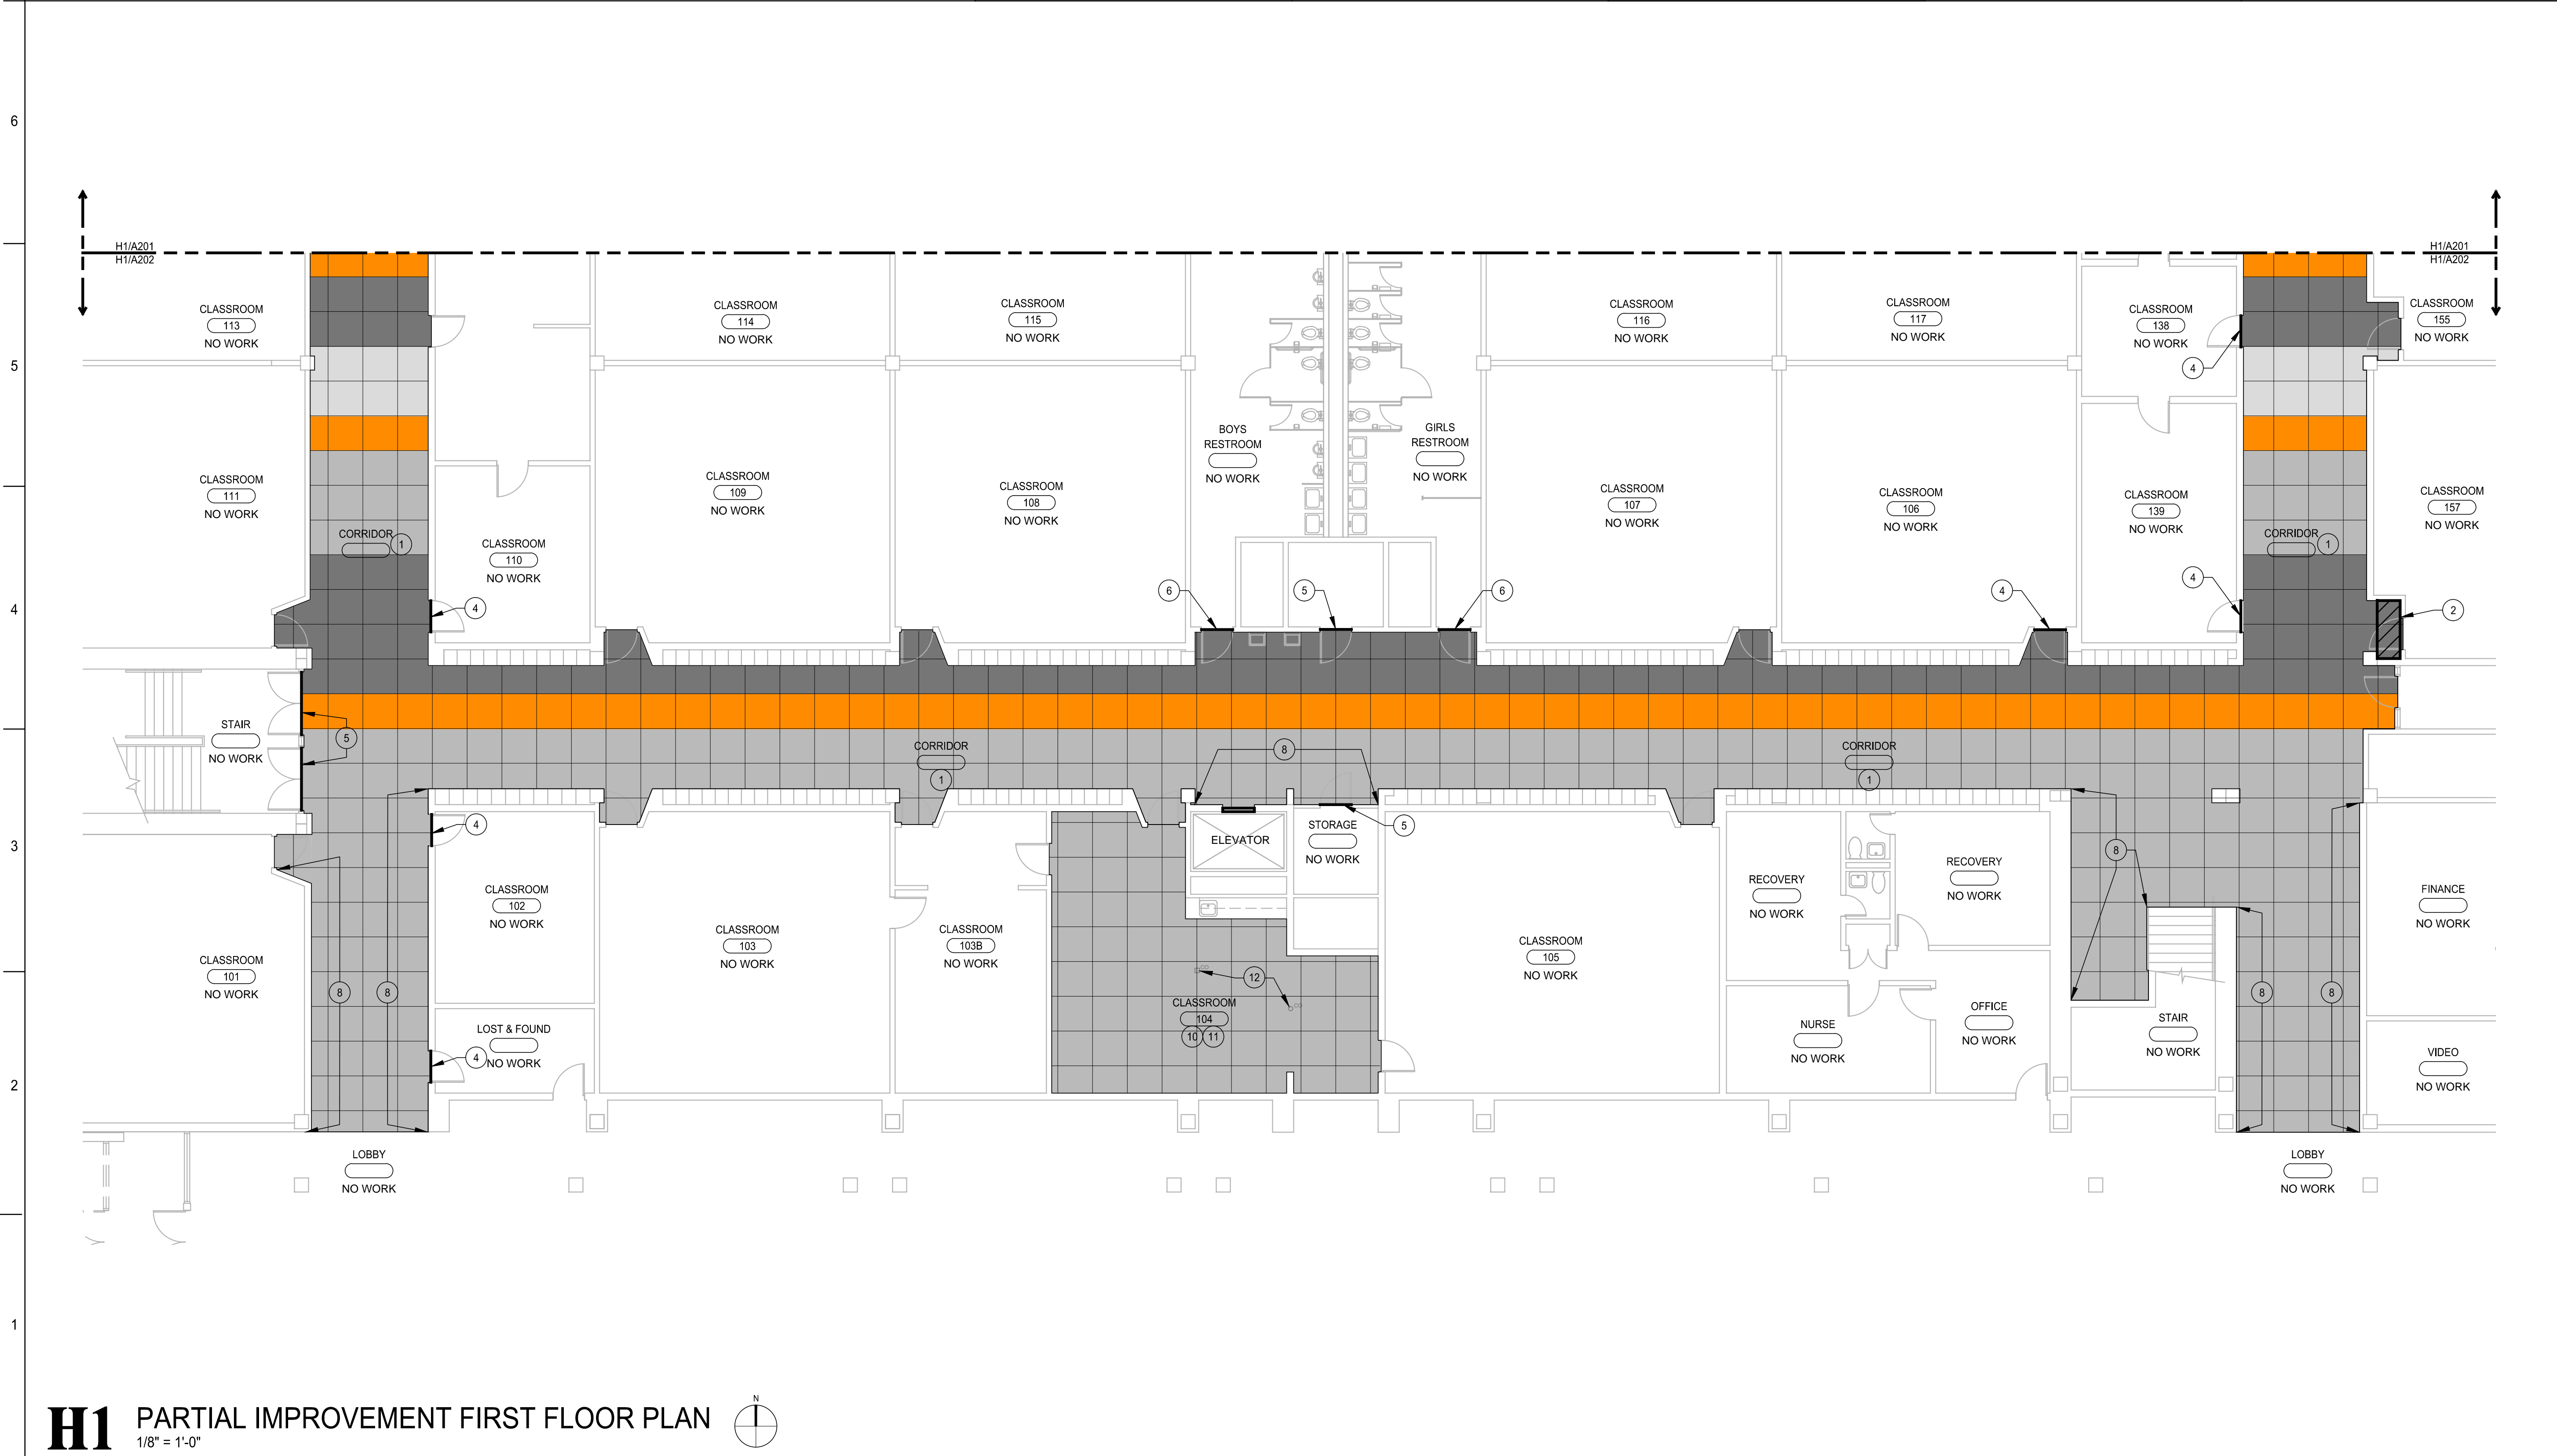

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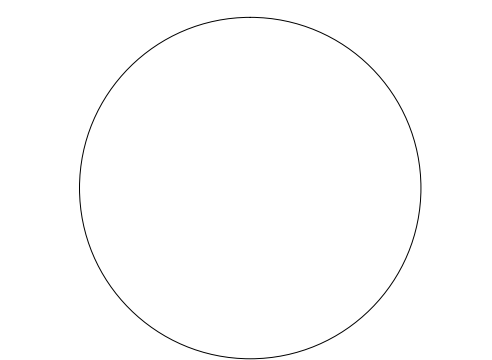
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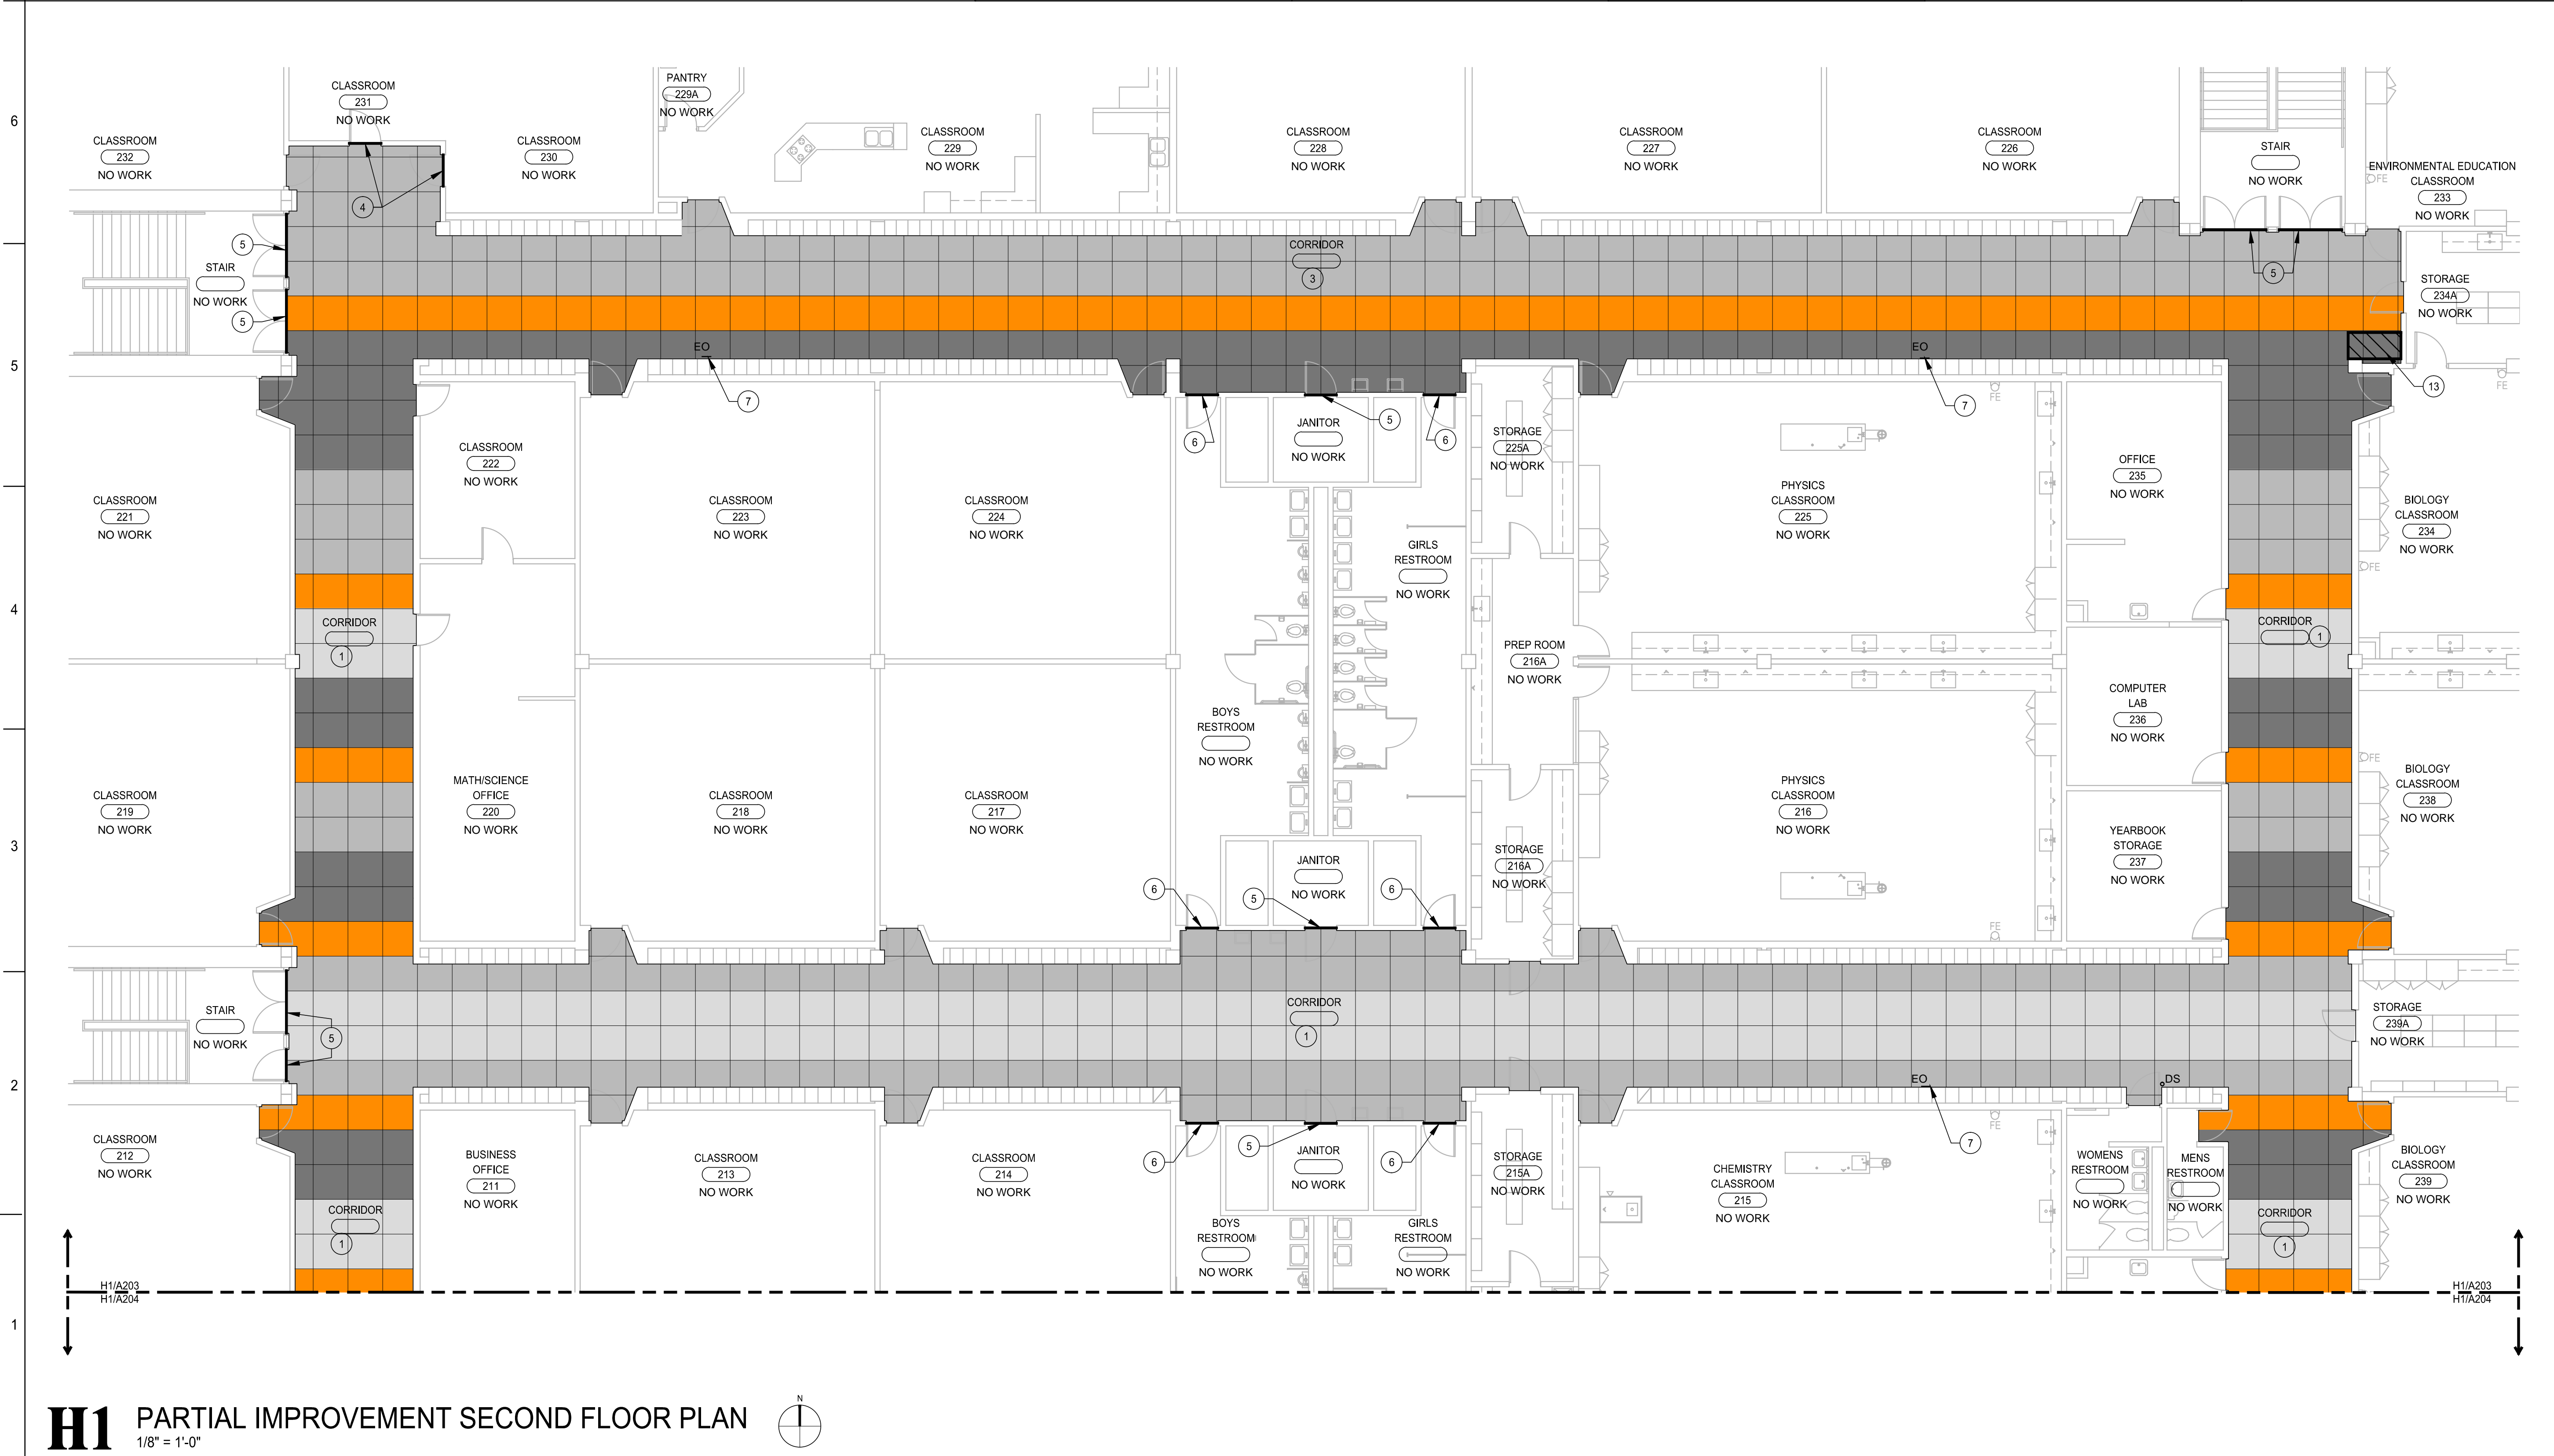
Revision Record

PARTIAL  
IMPROVEMENT  
FIRST  
FLOOR PLAN

SMNW  
A202



H	G	F	E	D	C	B	A
			<b>COLOR LEGEND</b>  BASIS OF DESIGN NORAMENT, SATURA; OR PRE BID APPROVED EQUAL  <div><div></div>COLOR-1: CYGNUS 5105</div> <div><div></div>COLOR-2: ARA 5110</div> <div><div></div>COLOR-3: JUPITER 5120</div> <div><div></div>COLOR-4 : CASTOR 5111</div>	<b>GENERAL NOTES</b>  1. REMOVE & SALVAGE EXISTING FLOOR MOUNTED DOOR STOPS IN ALL ROOM AFFECTED BY NEW FLOORING. REINSTALL UPON COMPLETION OF NEW FLOORING WORK. (NOTE: NOT ALL DS ARE SHOWN)  2. USE CAUTION WHILE REMOVING RESILIENT BASE FROM WALLS W/PAINTED GRAPHICS TO REMAIN. CONTRACTOR RESPONSIBLE TO REPAIR OR PAY FOR REPAIRS BY OWNER IF DAMAGED.  3. CONTRACTOR SHALL MOVE & REATTACH EXISTING FLOOR DISPLAY CASES TO LIMITS OF WORK.  4. FLOOR SHALL BE GRINDED, PREPPED & LEVEL PER RUBBER FLOORING MANUFACTURERS RECOMMENDATIONS SO IF NO TRANSITION STRIP IS IDENTIFIED THE NEW FLOORING SHALL BE PREPPED & LEVEL TO BE FLUSH W/EXISTING FLOOR FINISH REMAINING. THUS NOT REQUIRING ANY RESILIENT TRANSITION UNLESS OTHERWISE NOTED TO OCCUR.	<b>IMPROVEMENT PLAN NOTES CONT.</b>  8 EXISTING BRICK, DO NOT INSTALL RESILIENT BASE UNLESS NOTED OTHERWISE.  9 OWNER SHALL REMOVE CONTENTS OF DISPLAY CASE & REINSTALL UPON COMPLETION OF FLOORING INSTALL.  10 NEW RUBBER FLOORING & RESILIENT BASE, (MATCH EXISTING HEIGHT), PREP SUBSTRATE AS RECOMMENDED BY FLOOR MANUFACTURER.  11 OWNER SHALL REMOVE ALL FURNITURE, REFRIGERATOR, ETC. & REINSTALL UPON COMPLETION OF NEW WORK.  12 REINSTALL CLEANOUT COVERS UPON COMPLETION OF NEW FLOORING.  13 CONTRACTOR SHALL REINSTALL & ANCHOR STORED DISPLAY CASE IN ORIGINAL LOCATION.	<b>IMPROVEMENT PLAN NOTES</b>  1 NEW RUBBER FLOOR TILE & RESILIENT BASE (FIELD VERIFY HEIGHT TO MATCH EXISTING BASE) FLOORING CONTRACTOR SHALL PREP SUBSTRATE & INCLUDE FLOOR GRINDING, FLOOR LEVELING, PATCHING COMPOUNDS, CRACK REPAIR & CLEANING OF EXISTING SLAB ACCEPTABLE TO FLOOR MANUFACTURER.  2 FIELD VERIFY AREAS OF ADDITIONAL FLOOR PREP REQUIRED, PROVIDE CEMENTITIOUS LEVELING UNDERLAYMENT AS RECOMMENDED BY FLOOR MANUFACTURER.  3 CRACK REPAIR RE:H7/A201 AS RECOMMENDED BY FLOORING MANUFACTURER.  4 NEW TRANSITION @ RUBBER FLOORING & EXISTING CARPET.  5 NEW TRANSITION @ RUBBER FLOORING & EXISTING CONCRETE SLAB.  6 NEW TRANSITION @ RUBBER FLOORING & EXISTING RESINOUS FLOORING.  7 CUT NEATLY & TRIM NEW BASE AROUND ELECTRICAL OUTLET MOUNTED IN BASE.	<b>LEGEND-NEW WORK</b>  EXISTING CONST. TO REMAIN  # NOTE APPLIES TO SPECIFIC ITEM # NOTE APPLIES TO ENTIRE ROOM U.N.O. H1/A201 ELEVATION MARK (IDENTIFIER/ SHEET NUMBER) H1/A201 ENLARGED AREA/ DETAIL BLOWUP (IDENTIFIER/ SHEET NUMBER) EJ EXPANSION JOINT <div></div> NEW RUBBER TILE FLOORING & RESILIENT BASE <div></div> NEW TRANSITION STRIP EO ELECTRICAL OUTLET DS DOOR STOP <div></div> NEW - CARPET & RESILIENT BASE





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2017  
FLOORING  
IMPROVE-  
MENTS

SHAWNEE  
MISSION  
NORTHWEST  
HIGH  
SCHOOL

12701 W 67TH STREET  
SHAWNEE, KS 66216

ISSUE RECORD

FOR BID/CONSTRUCTION 01/31/2017

Revision Record

PARTIAL  
IMPROVEMENT  
SECOND  
FLOOR PLAN

SMNW

A203



